

#### LOCATION PLAN

REV. REVISION/ ISSUE DESRCIPTION

A FOR DEVELOPMENT APPROVA

# City of HOBART

# HOBART COUNCIL CENTRE 16 ELIZABETH STREET GPO BOX 503 T: (03) 6238 2711 F: (03) 6234 9757


#### **GENERAL NOTES:**

- THESE DRAWINGS, WHERE APPLICABLE ARE TO BE READ IN CONJUNCTION WITH THE ARCHITECTURAL OR ENGINEERING PLANS, CONTRACT AND SPECIFICATIONS. ANY DISCREPANCIES ARE TO BE REPORTED IMMEDIATELY.
- DIMENSIONS SHALL NOT BE SCALED FROM THE DRAWINGS. DIMENSIONS SHALL BE CHECKED ON-SITE BEFORE PROCEEDING WITH THE WORK.
- WORKMANSHIP AND MATERIALS ARE TO BE IN ACCORDANCE WITH THE RELEVANT CURRENT AUSTRALIAN STANDARDS INCLUDING ALL AMENDMENTS AND LGAT-IPWEA APPROVED STANDARD DRAWINGS EXCEPT WHERE VARIED BY THE CONTRACT DOCUMENTS.
- ALL PROPRIETARY ITEMS ARE TO BE INSTALLED AND FIXED IN ACCORDANCE WITH THE MANUFACTURERS SPECIFICATIONS AND INSTRUCTIONS.
- ALL WORK IS TO BE CARRIED OUT IN ACCORDANCE WITH CODE OF PRACTICE-SAFE WORKS AUSTRALIA REQUIREMENTS AND OCCUPATIONAL HEALTH AND SAFETY ACT REGULATIONS.
- SERVICES SHOWN ON THESE DRAWINGS HAVE BEEN EXTRACTED FROM HOBART CITY COUNCIL GIS SYSTEM AND DBYD PLAN. THE POSITION OF EXISTING SERVICES IS APPROXIMATE ONLY. THE CONTRACTOR SHALL BE RESPONSIBLE FOR THE LOCATION OF ALL EXISTING SERVICES AND ANY DAMAGE CAUSED SHALL BE REPAIRED AT THE CONTRACTOR'S EXPENSES.
- CONFIRM ALL LEVELS ON-SITE PRIOR TO THE COMMENCEMENT OF WORKS.
- ANY DEPARTURES FROM THE DESIGN DRAWINGS ARE TO BE AT THE WRITTEN APPROVAL OF THE SUPERINTENDENT'S REP.
- WHERE REQUIRED THE CONTRACTOR SHALL PREPARE AN ELECTRONIC (DWG) FORMAT "AS CONSTRUCTED" DRAWINGS TO THE SATISFACTION OF THE SUPERINTENDENT'S REP SHOWING THE AS INSTALLED LOCATION OF ALL ABOVE AND BELOW GROUND WORKS.


#### DRAWING REGISTER:

DWG. NO.	DWG. TITLE	REV. NO.
A001	COVER PAGE	В
L-10	LANDSCAPE WORKS - LANDSCAPE PLAN	В
L-20	LANDSCAPE WORKS - LEVELS PLAN	Α
L-30	LANDSCAPE WORKS - PLANTING PLAN	Α
L-40	LANDSCAPE WORKS - MATERIALS SCHEDULE	Α
A002	SITE PLAN	Α
A101	DEMOLITION PLAN	Α
A201	ARCHITECTURE WORKS - SHELTER PLAN, SECTION & ELEVATION	Α
A202	ARCHITECTURE WORKS - SHELTER PERSPECTIVE	Α
A203	ARCHITECTURE WORKS - BUS STOP & TOILET PLANS & SECTIONS	В
A204	ARCHITECTURE WORKS - BUS STOP & TOILET ELEVATIONS	Α
A205	ARCHITECTURE WORKS - BUS STOP & TOILET PERSPECTIVE 1	Α
A206	ARCHITECTURE WORKS - BUS STOP & TOILET PERSPECTIVE 2	Α
C201	CIVIL WORKS - GENERAL ARRANGEMENT PLAN	D
C202	CIVIL WORKS - SUMMERLEAS/STEPHENSON INTERSECTION	D
C203	CIVIL WORKS - FERN GLADE CAR PARK	D
C301	CIVIL WORKS - 20 YEAR RAIN EVENT CALCS AND FLOW PATHS	Α
C501	CIVIL WORKS - FOOTPATH SECTIONS	Α
C901	CIVIL WORKS - COACH TURN PATH	А

PROJECT DESCRIPTION	DRAWN	RFS NUMBER	
FERN TREE PARK VISITOR NODE MASTER PLAN IMPLEMENTATION	A0		S17-0109
	CHECKED	F480509 Fer	n Tree Shelte
DRAWING TITLE	MS		& Bus Stop.dw
COVER PAGE	DISCIPLINE	SHEET SIZE	
COVER TAGE	Α		ΑJ
CLIENT	SHEET NUN	1BER	REVISION
GREG MILNE - BUSHLAND AND RESERVES GROUP	ฃ∧∧	Λ1	D
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### **FERNTREE PARK - LANDSCAPE MATERIALS PALETTE**
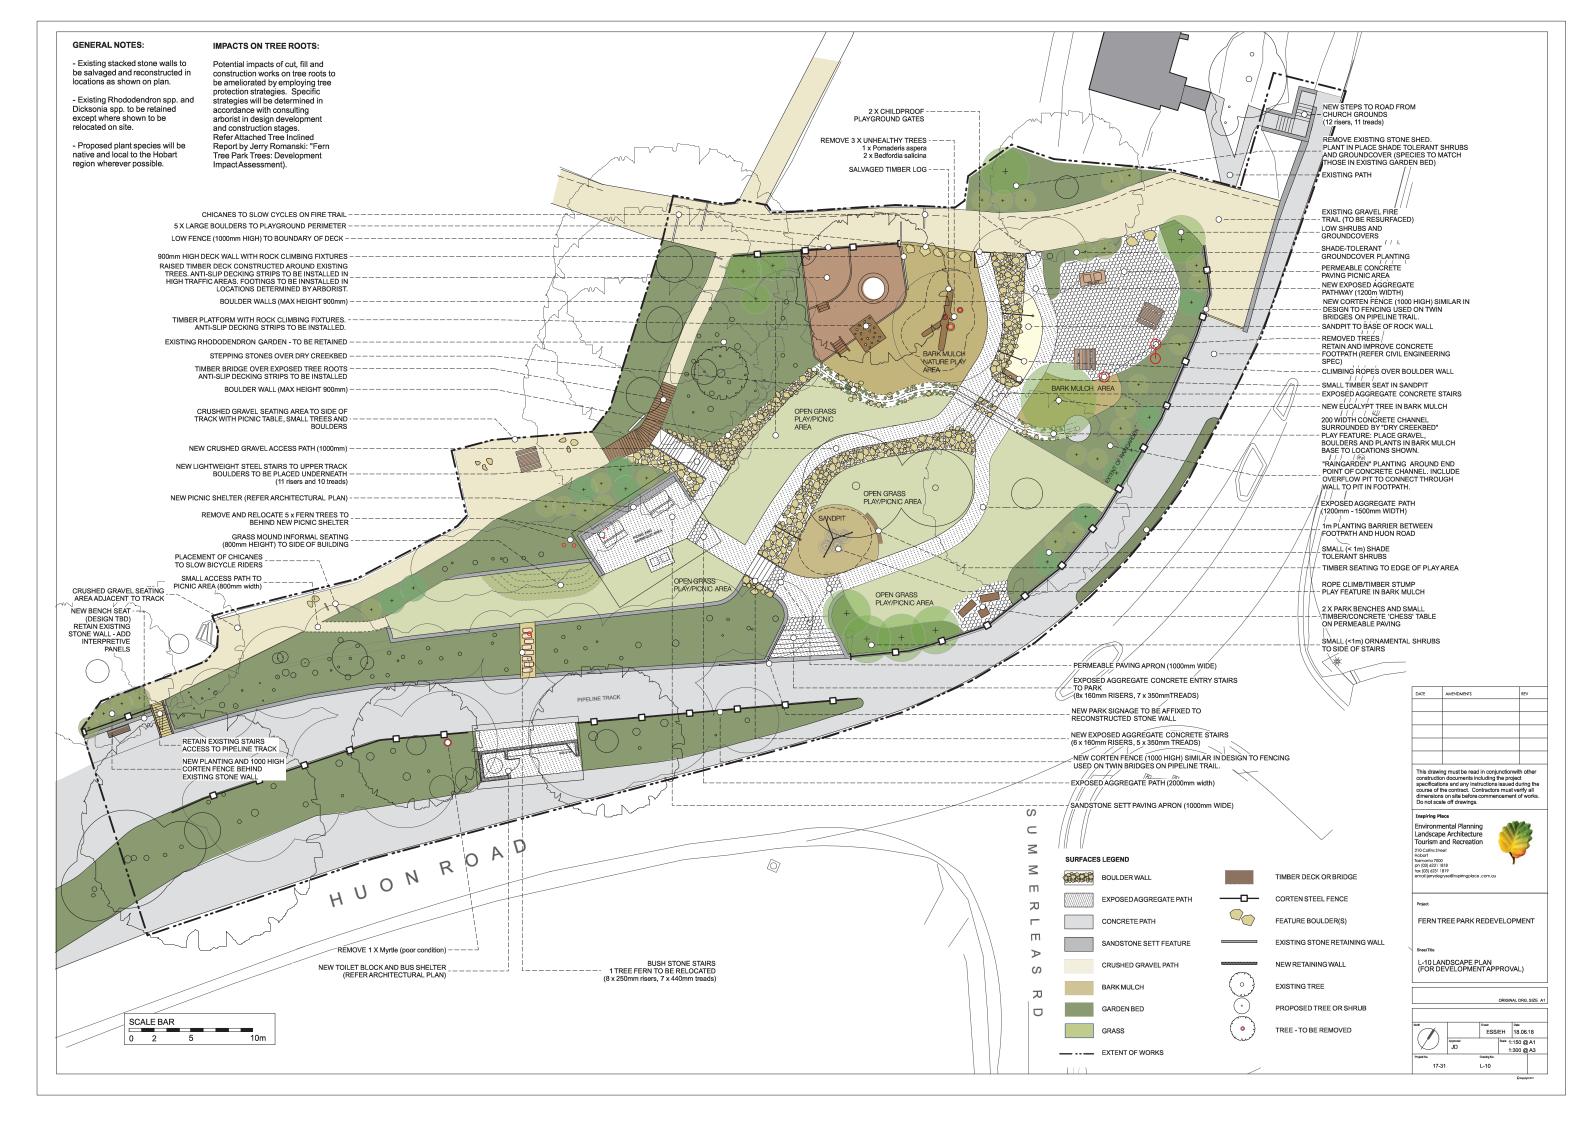
#### PATHS AND PAVING



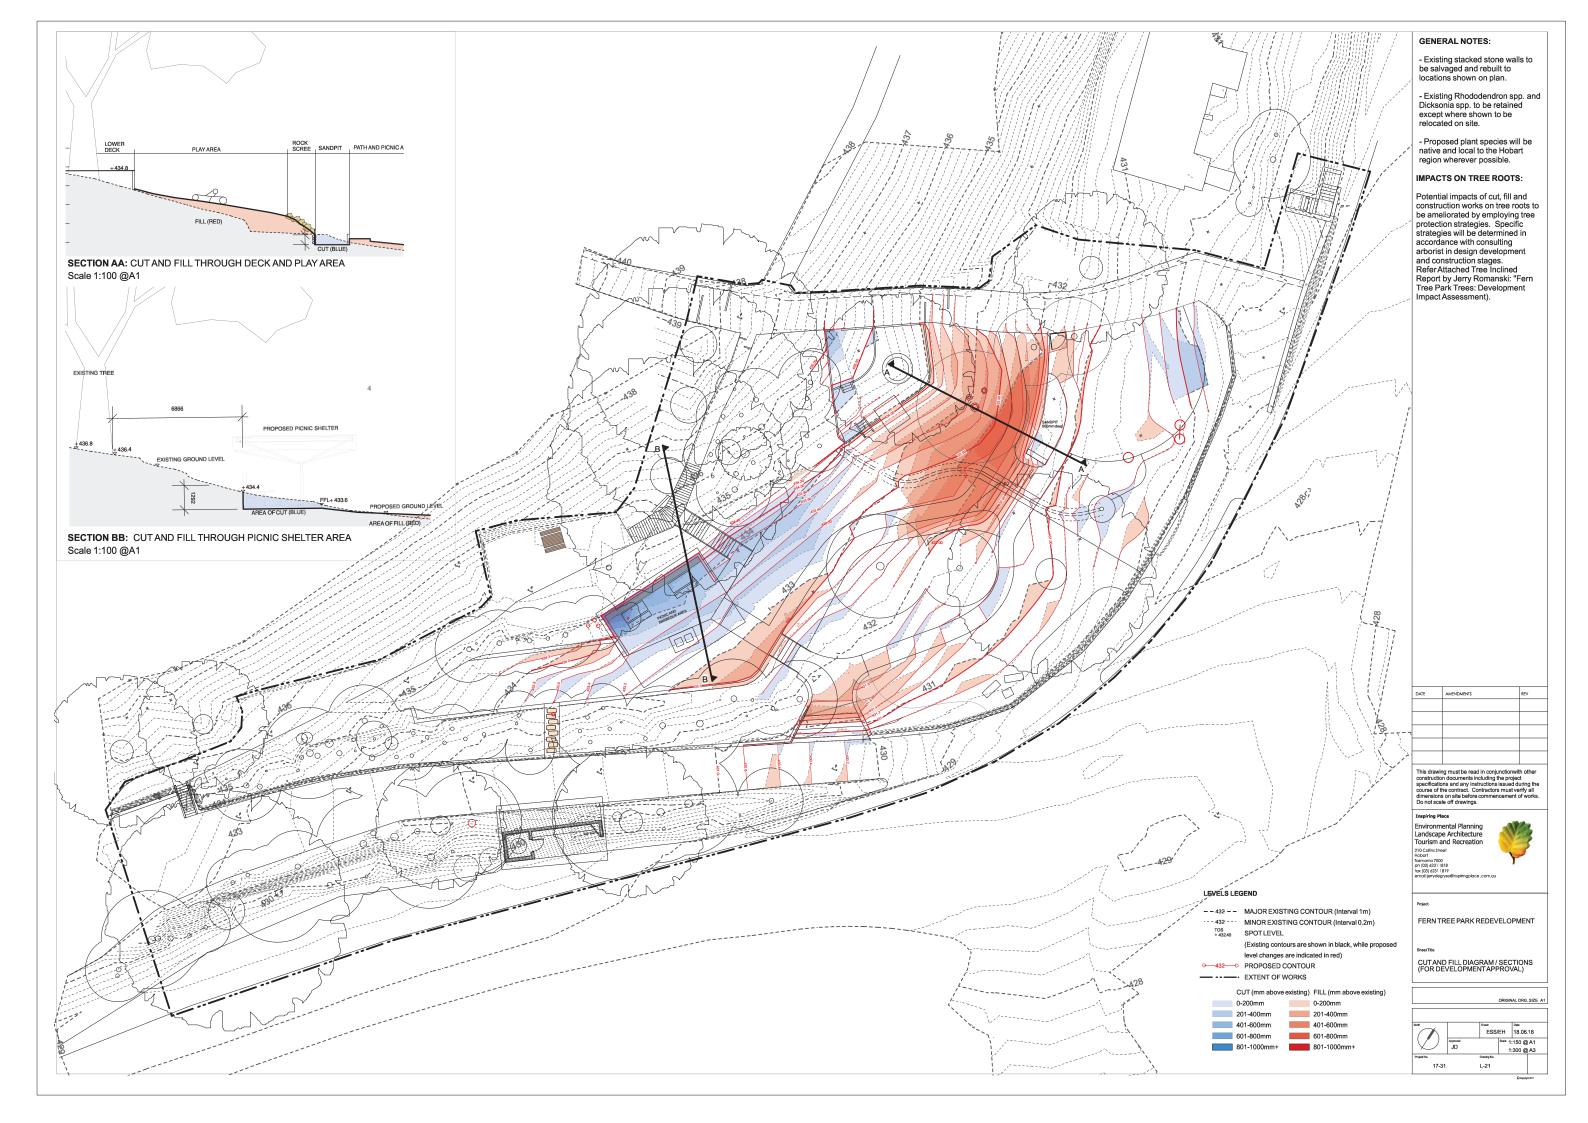











Sandstone cobblestones Cobblestone apron

Imagecrete 'Derwent'

Exposed ag. path - Hanson Permeable concrete paving Crushed limestone gravel path

Stone steps

Timber bridge

**TIMBER DECK** 

**FENCING** 

PARK FURNITURE (as per Wellington Park Design Manual)







Spotted Gum Timber Decking around existing tree Corten fencing (900mm high)

Picnic table

BBQ

#### **NATURE PLAY ELEMENTS**









Boulder Rope Climb (max height 1.5m)

Timber stumps and salvaged logs

Timber 'rockclimb' feature to deck


Dry creekbed - local stone and native wetland plants


NOTE: All materials and construction to adhere to	Wellington Trust Design and Infrastructure Manual
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L-40 MATERIALS SCHEDULE (FOR DEVELOPMENT APPROVAL)						
			ORIGIN	AL DRG	SIZE A1	
North		Drawn		Date		
		ESS/	EH	18.06.	18	
	JD			150 @ 300 @		
Project No.		Drawing No.				
17-31		L-40				
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FERN TREE PARK REDEVELOPMENT










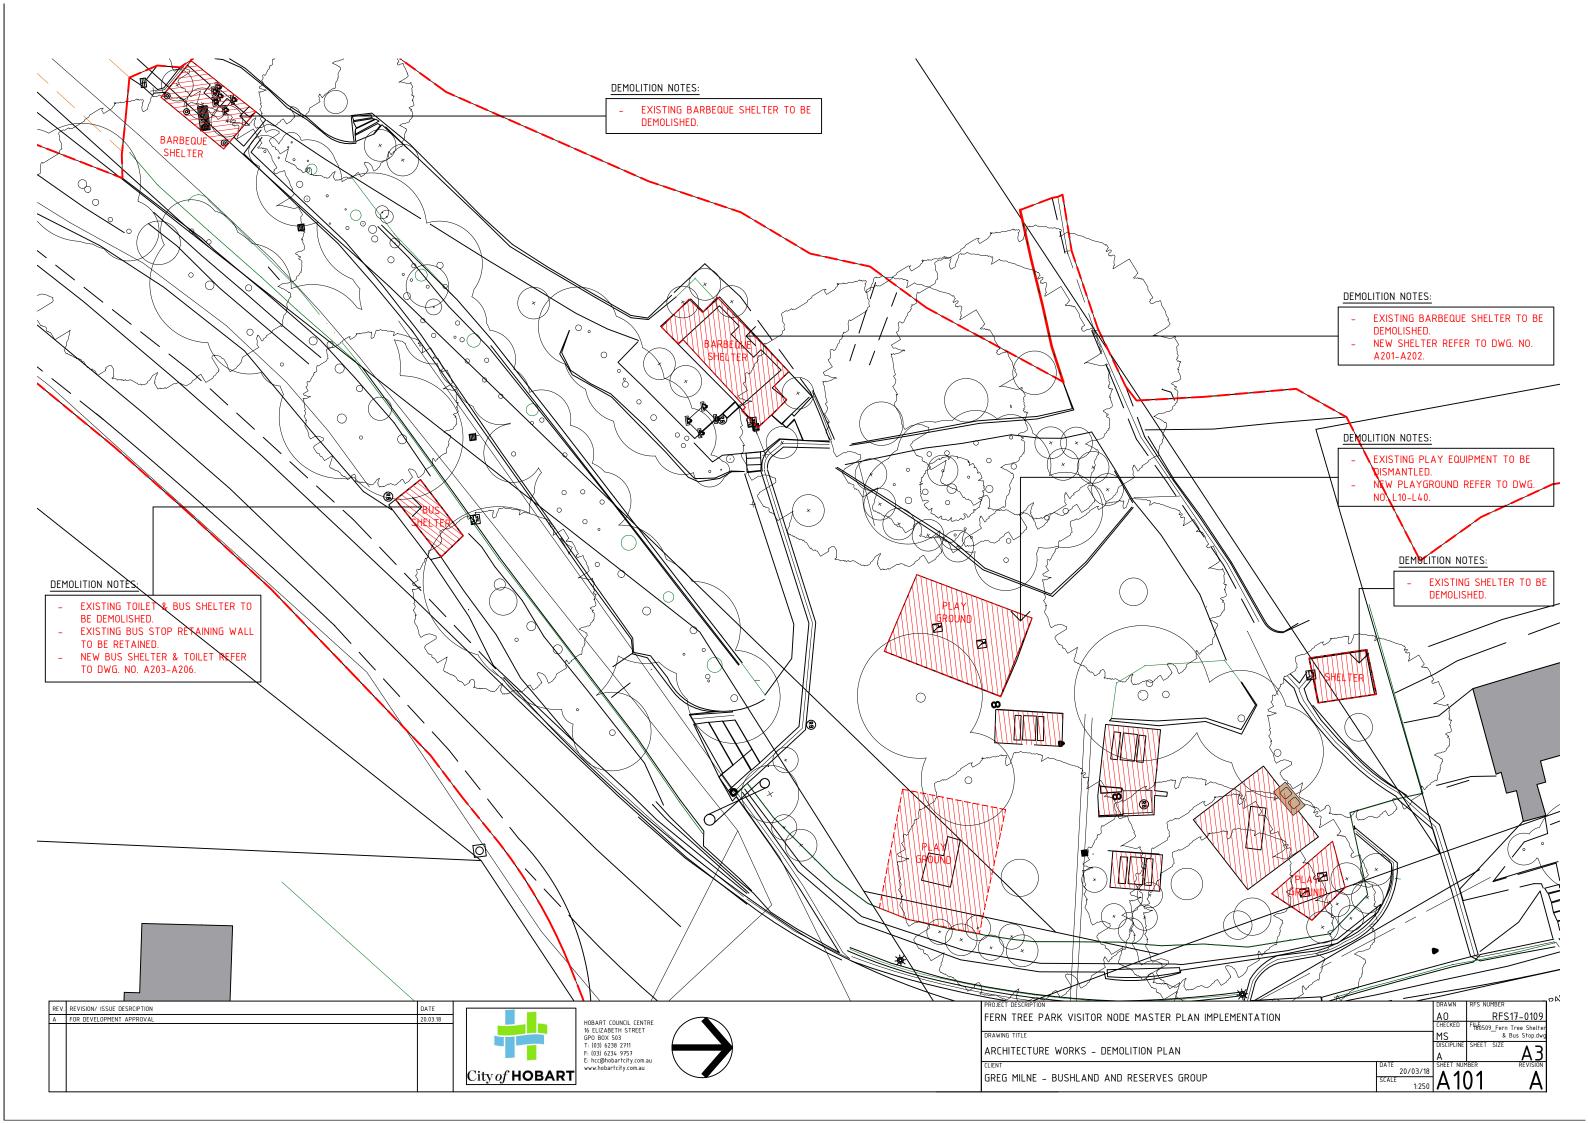

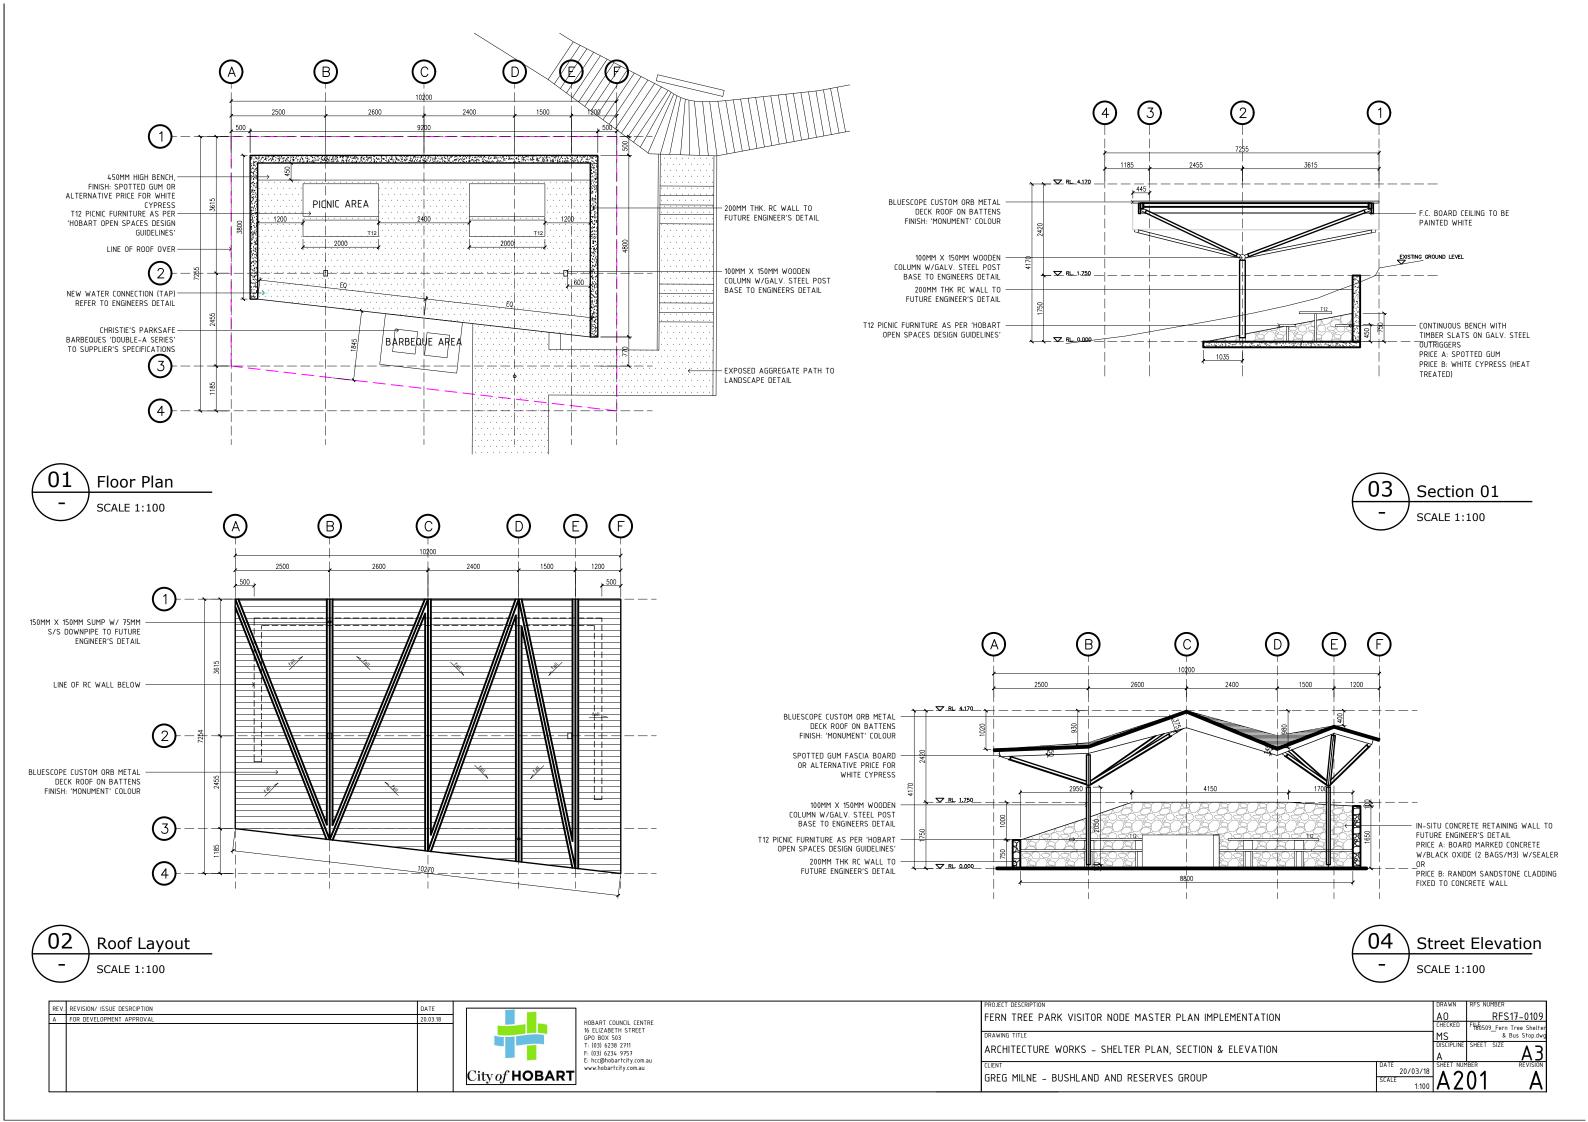

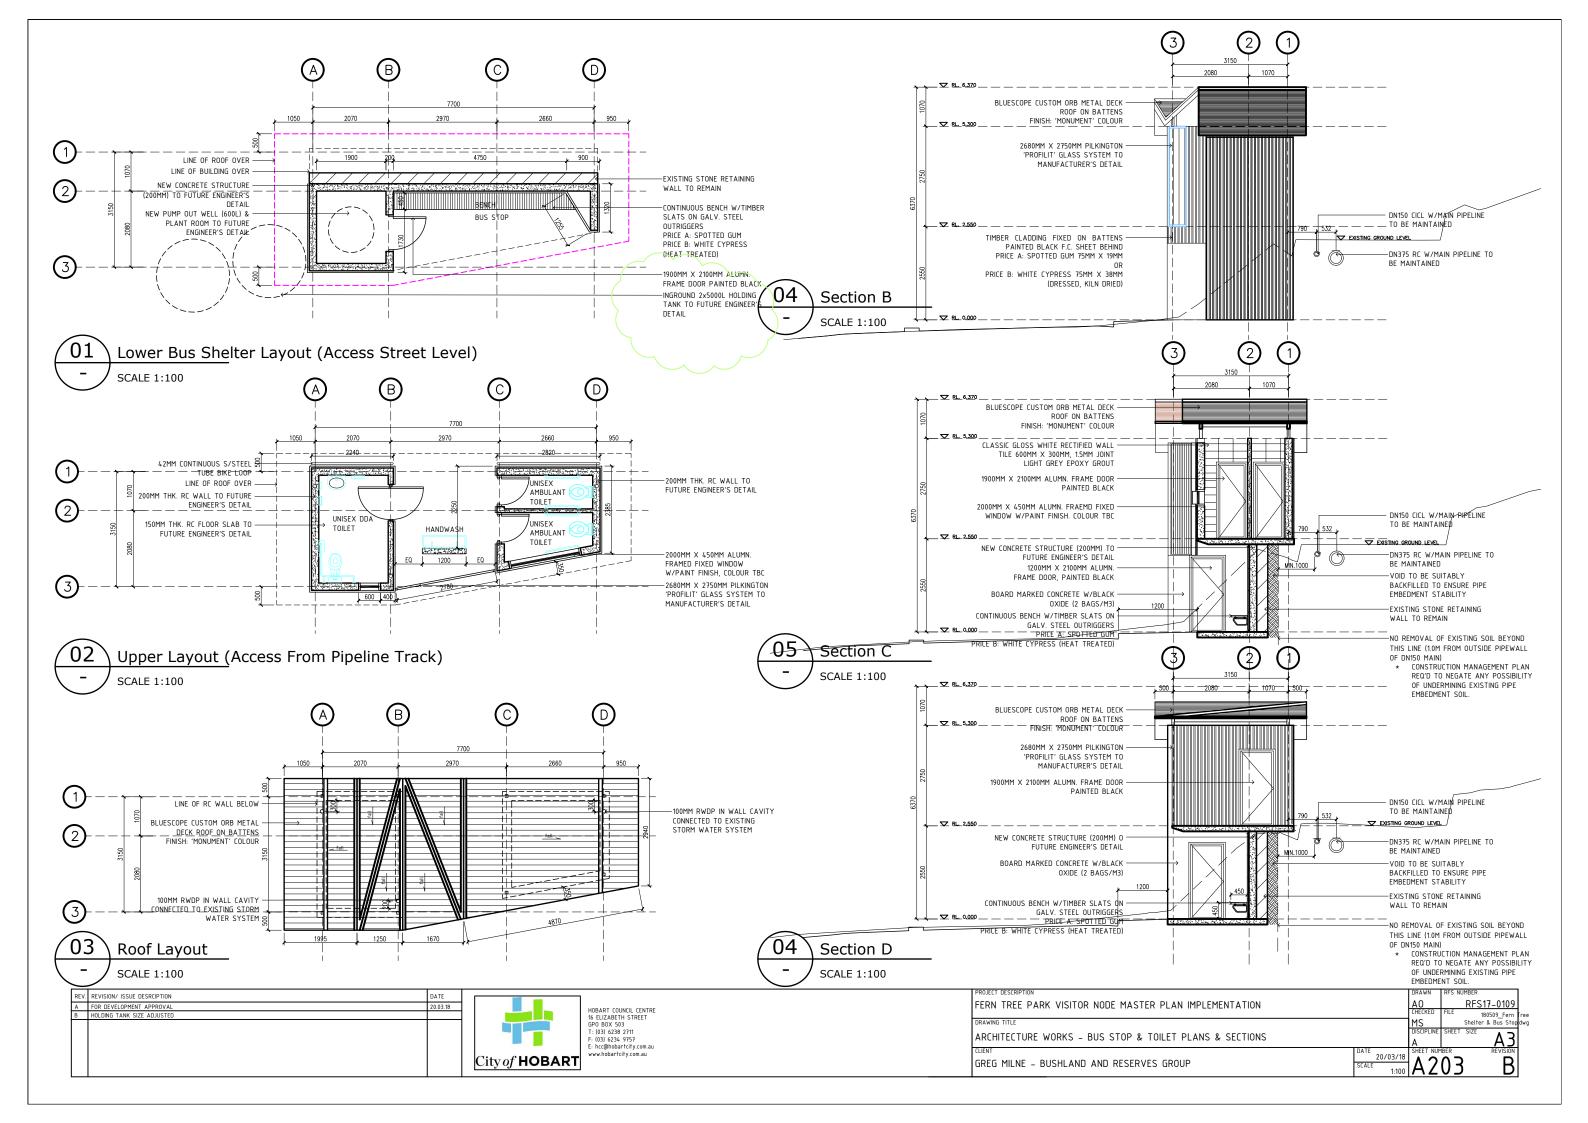

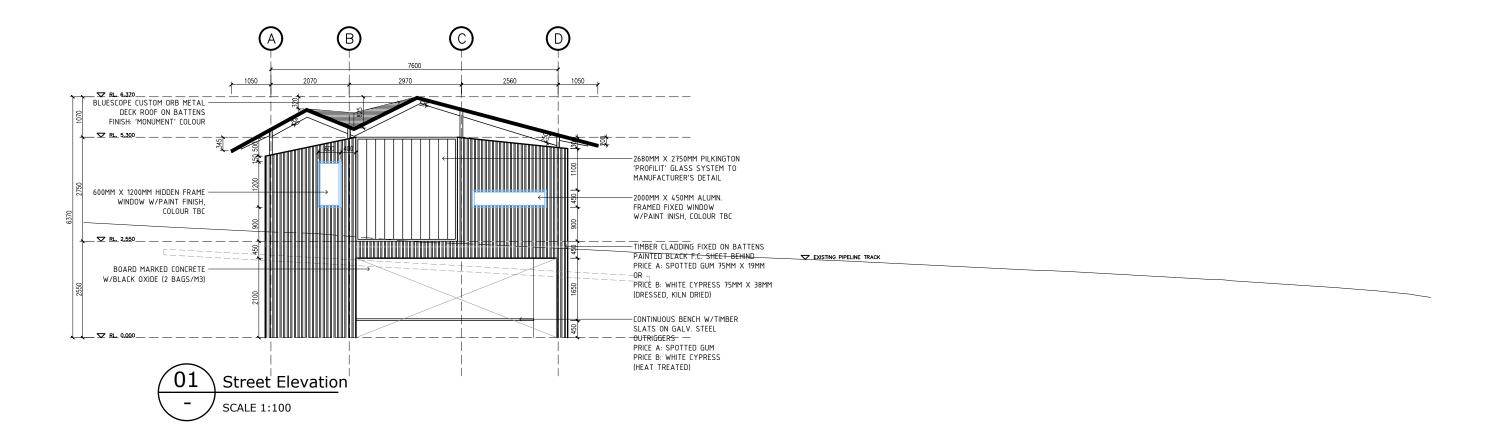

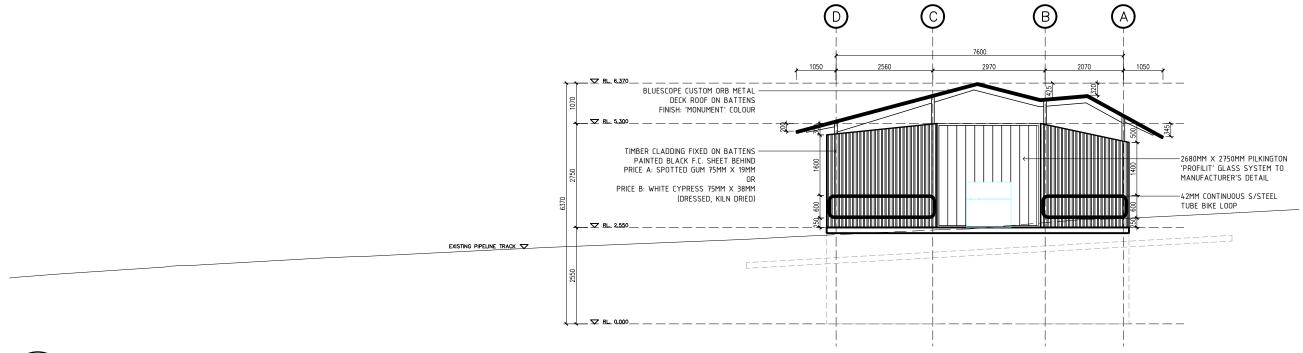

Pipeline Track Elevation

SCALE 1:100


REV REVISION/ ISSUE DESCRIPTION			PROJECT DESCRIPTION	DRAWN	RFS NUMBER
A FOR DEVELOPMENT APPROVAL 20	18	HOBART COUNCIL CENTRE 16 ELIZABETH STREET	FERN TREE PARK VISITOR NODE MASTER PLAN IMPLEMENTATION	AO CHECKED	RFS17-0109
		FO BOX 503 T: (03) 6238 2711 F: (03) 6238 2757	DRAWING TITLE  ARCHITECTURE WORKS - BUS STOP & TOILET ELEVATIONS	MS DISCIPLIN	Shelter & Bus Stop dwg
	City of HOBART	GREG MILNE - BUSHLAND AND RESERVES GROUP  DATE 2 SCALE	20/03/18 SHEET NU 1:100 A 2	204 A	









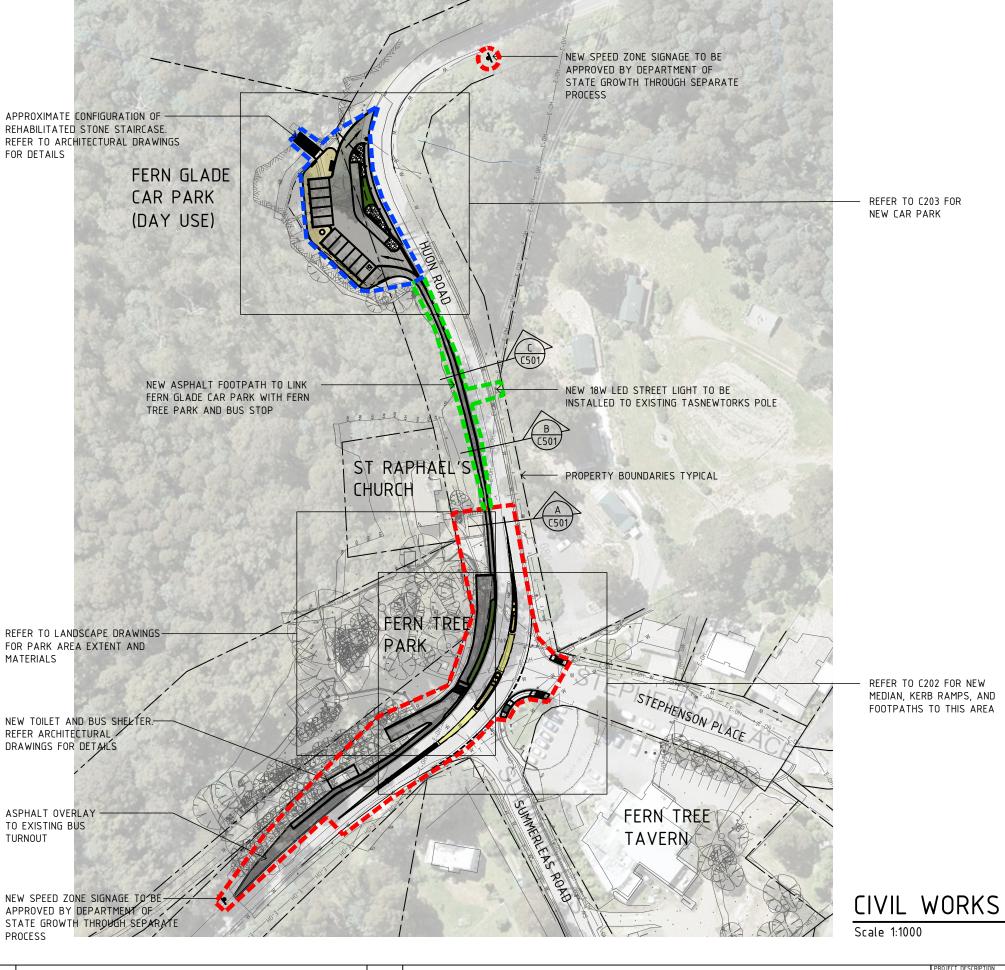

#### CIVIL NOTES:

- 1. LIGHT GREY LINES REPRESENT EXISTING CONDITIONS. DARK BLACK LINES AND HATCHING REPRESENT THE EXTENT OF NEW CIVIL WORKS. FOR NEW ARCHITECTURAL AND LANDSCAPE WORK REFER TO THE ARCHITECTURAL AND LANDSCAPE DRAWING PACKAGES RESPECTIVELY
- 2. NEW AND UPGRADED FOOTPATHS WITHIN THE ROAD RESERVATION WILL BE CONSTRUCTED IN GENERAL ACCORDANCE WITH TASMANIAN STANDARD DRAWING TSD-R11-v1 AND TO THE SATISFACTION OF THE DIRECTOR CITY INFRASTRUCTURE
- 3. NEW KERB AND GUTTER AND VEHICULAR CROSSINGS WITHIN THE ROAD RESERVATION WILL BE CONSTRUCTED IN GENERAL ACCORDANCE WITH TASMANIAN STANDARD DRAWING TSD-R14-v1 AND TO THE SATISFACTION OF THE DIRECTOR CITY
- NEW VEE CHANNEL VEHICULAR CROSSING TO BE CONSTRUCTED IN ACCORDANCE WITH TASMANIAN STANDARD DRAWING TSD-R14-v1 AND TO THE SATISFACTION OF THE DIRECTOR CITY INFRASTRUCTURE
- ALL NEW KERB RAMPS WILL BE CONSTRUCTED IN ACCORDANCE WITH TASMANIAN STANDARD DRAWING TSD-R18-v1 AND TO THE SATISFACTION OF THE DIRECTOR CITY **INFRASTRUCTURE**
- ALL NEW MEDIAN ISLANDS WILL BE DESIGNED AND CONSTRUCTED IN GENERAL ACCORDANCE WITH TASMANIAN STANDARD DRAWING TSD-R20-v1 AND TO THE SATISFACTION OF THE DIRECTOR CITY INFRASTRUCTURE

#### CIVIL MATERIAL NOTES:

- 1. NEW CONCRETE KERBS TO BE TYPE KC KERB WITH 10mm SPRAY SEAL FROM THE LIP TO THE INVERT
- 2. NEW ASPHALT FOOTPATHS TO BE 1200mm MINIMUM WIDTH AND BE FINISHED WITH A CONTINUOUS STEEL EDGE TO THE BACK OF THE FOOTPATH

#### CIVIL WORKS CONSTRUCTION STAGING LEGEND:


STAGE 1. WORKS DIRECTLY ASSOCIATED WITH THE FERN TREE PARK ENTRANCE AND SPEED ZONE SIGNAGE

STAGE 2. WORKS DIRECTLY ASSOCIATED WITH THE FERN GLADE CAR PARK UPGRADE

STAGE 3. CONSTRUCTION OF THE FOOTPATH CONNECTING FERN TREE PARK AND FERN GLADE CAR PARK INCLUDING NEW STREET LIGHT

## CIVIL WORKS SCOPE

REV. REVISION/ ISSUE DESRCIPTION	DATE		PROJECT DESCRIPTION	DRAWN RFS NUMBER
A FOR QUANTITY SURVEYOR  B DA CHIRMISCION	02.03.18 28.03.18	HOBART COUNCIL CENTRE	FERN TREE PARK VISITOR NODE MASTER PLAN IMPLEMENTATION	RU RFS17-0109 CHECKED FILE 17-0109 FERN
C DA SUBMISSION D DA ADDITIONAL INFORMATION PROJEST	08.05.18	16 ELIZABETH STREET GPO BOX 503 T: (03) 6238 2711	DRAWING TITLE	GPT TREE_WD.dwg
D DA AUDTIONAL INFORMATION REQUEST	29.05.18	F: (03) 6234 9757 E: hcc@hobartcity.com.au	CIVIL WORKS - GENERAL ARRANGEMENT PLAN	[c   A3
	City of HC		GREG MILNE - BUSHLAND AND RESERVES GROUP	SCALE 1:1000 C 201

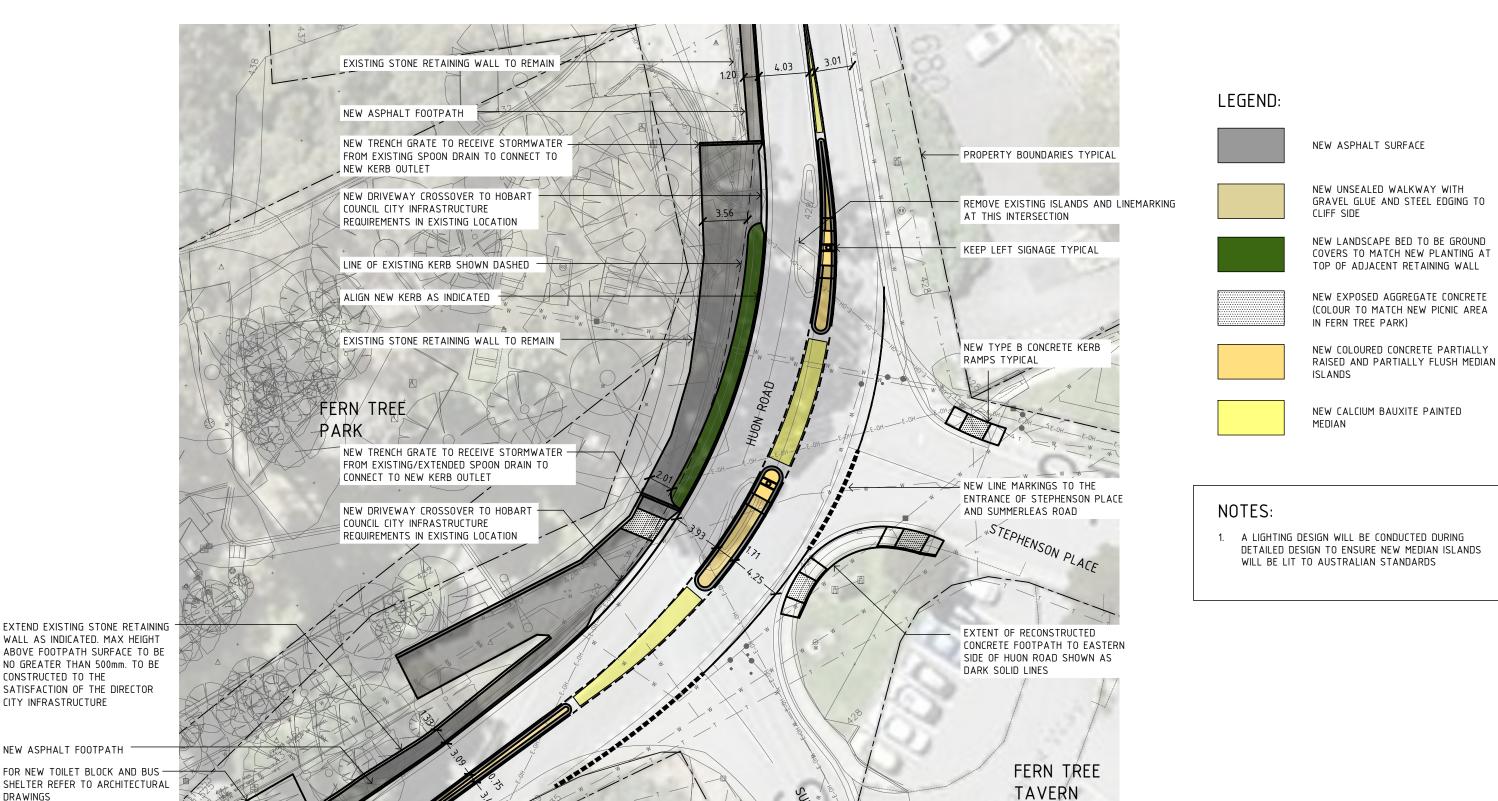

NEW ASPHALT FOOTPATH

CONSTRUCTED TO THE SATISFACTION OF THE DIRECTOR

CITY INFRASTRUCTURE

FOR NEW TOILET BLOCK AND BUS SHELTER REFER TO ARCHITECTURAL DRAWINGS

WALL AS INDICATED. MAX HEIGHT

NO GREATER THAN 500mm. TO BE

NEW STORMWATER KERB OUTLET

## SUMMERLEAS/ STEPHENSON **INSTERSECTION**

REV.	REVISION/ ISSUE DESRCIPTION	DATE
Α	FOR QUANTITY SURVEYOR	02.03.18
В	DA SUBMISSION	28.03.18
С	DA SUBMISSION	08.05.18
D	DA ADDTIONAL INFORMATION REQUEST	29.05.18





LINE OF EXISTING EDGE OF ASPHALT

PROJECT DESCRIPTION	1	DRAWN	RFS NU	MBER
FERN TREE PARK VISITOR NODE MASTER PLAN IMPLEMENTATION		RU		RFS17-0109
	(	HECKED	FILE	17-0109 FERN
DRAWING TITLE	(	GPT		TREE_WD.dwg
CIVIL WORKS - SUMMERLEAS/ STEPHENSON INTERSECTION	Ī	DISCIPLINE	SHEET	SIZE A D
				A3
CLIENT DATE		SHEET NUM	BER	REVISION
GREG MILNE - BUSHLAND AND RESERVES GROUP	29/05/18	てつり	1つ	ח
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#### LEGEND:



NEW ASPHALT FOOTPATH AND CAR PARK SURFACE. CAR PARK ASPHALT AREA = 415m<sup>2</sup> EXISTING CAR PARK HAS 11 CAR SPACES RE-SURFACED CAR PARK WILL HAVE 16 CAR SPACES (5 ADDITIONAL)



NEW UNSEALED WALKWAY WITH GRAVEL GLUE AND STEEL EDGING TO CLIFF SIDE




NEW LANDSCAPE SWALE TO BE GROUND COVER PLANTS NO HIGHER THAN 700mm



FIXED ROCK SWAYLE TO ACT AS DIFFUSER FOR FLOWING STORMWATER

## FERN GLADE CAR PARK (DAY USE)

REV. REVISION/ ISSUE DESRCIPTION	DATE		PROJECT DESCRIPTION	DRAWN RFS NUMBER
A FOR QUANTITY SURVEYOR B DA SUBMISSION	02.03.18 28.03.18	HOBART COUNCIL CENTRE	FERN TREE PARK VISITOR NODE MASTER PLAN IMPLEMENTATION	RU RFS17-0109 CHECKED FILE 17-0109 FERI
C DA SUBMISSION D DA ADDTIONAL INFORMATION REQUEST	08.05.18 29.05.18	16 ELIZABETH STREET GPO BOX 503 T: (03) 6238 2711 F: (03) 6234 9757	DRAWING TITLE  CIVIL WORKS - FERN GLADE CAR PARK	GPT TREE_WD.dwg
	City of <b>I</b>	E: hcc@hobartcity.com.au	CLIENT	DATE 29/05/18 C 2 A D
	City of <b>H</b>	HOBART www.hobartcity.com.au	GREG MILNE - BUSHLAND AND RESERVES GROUP	29/05/18 C 203

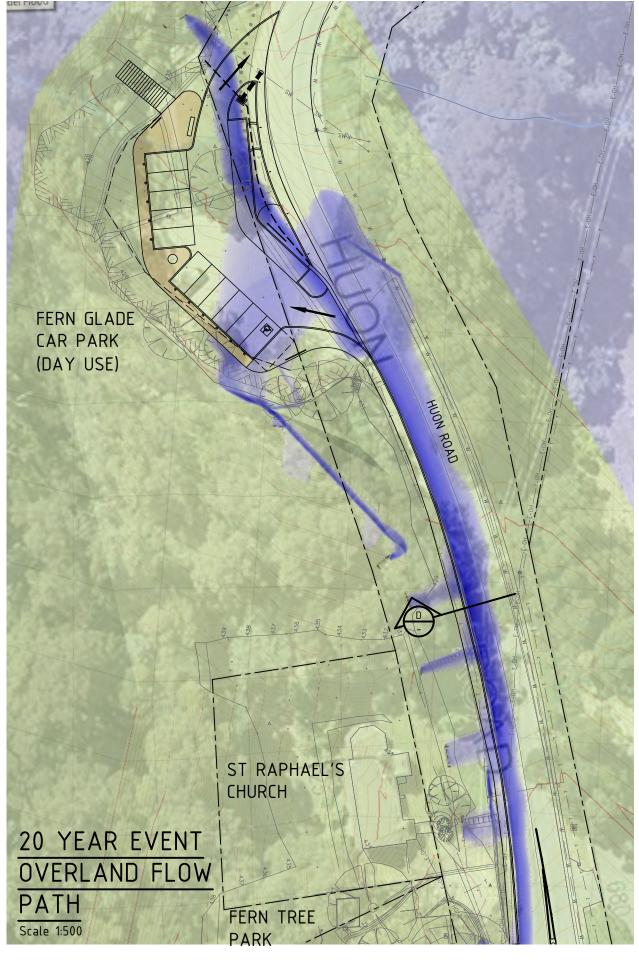




## CATCHMENT AREA

Scale NA

	CATCHMENT CHAP	RACTERISTI	CS					
CATCHMENT	CATCHMENT AREA	TRAVEL DISTANCE	AVERAGE SLOPE	RUNOFF COEFFICENT	OVERLAND FLOW TIME	RECOURENCE INTERVAL	RAINFALL INTENSITY	TOTAL CATCHMENT DISCHARGE FLOW
	Ac	L	Sc	C	to	(ARI)	6	Qc
	(ha)	(m)	(%)		(min)		(mm/hr)	(m3/s)
					1 = 92.7U(A" 5, 13)			Q . CIA, 10.36
					[Bransby Williams formula NAASRA (1986)]			[Rational formula NAASRA (1986)]
Area 2	5.700000	370	3.700	0.5	14.0	1	21.2	0.168
						2	28.7	0.227
						5	40.8	0.323
						10	49.3	0.390
						20	61	0.483
						50	77	0.610
						100	91	0.720

# CALCULATIONS FOR 20 YEAR EVENT

Scale NA

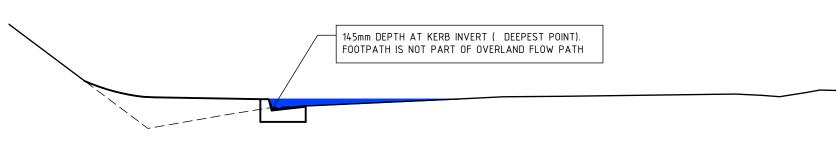

## SECTION D - MAXIMUM WATER DEPTH


Scale 1:50


REV.	REVISION/ ISSUE DESRCIPTION	DATE	Γ
Α	DA ADDTIONAL INFORMATION REQUEST	29.05.18	
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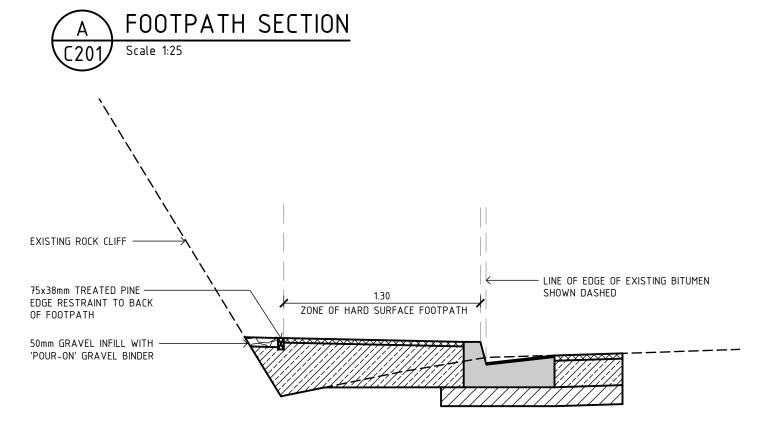




PROJECT DESCRIPTION		DRAWN	RFS NU	MBER
FERN TREE PARK VISITOR NODE MASTER PLAN IMPLEMENTATION		RU		RFS17-0109
		CHECKED	FILE	17-0109_FERN
DRAWING TITLE		GPT		TREEWD.dwg
CIVIL WORKS - 20 YEAR RAIN EVENT CALCULATIONS AND FLOW PATHS		DISCIPLINE	SHEET	SIZE A D
		C		<u> </u>
CLIENT	29/05/18	SHEET NUM	BER	REVISION
GREG MILNE - BUSHLAND AND RESERVES GROUP	CALE	וראו	۱1	Λ
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#### NOTES:


 EDGE OF EXISTING ASPHALT TO ALIGN WITH NEW KERB INVERT IN ORDER TO MAINTAIN EXISTING ROAD WIDTH UNLESS SPECIFIED OTHERWISE

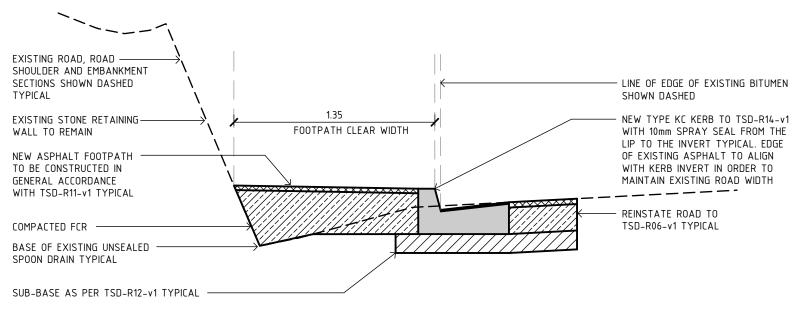

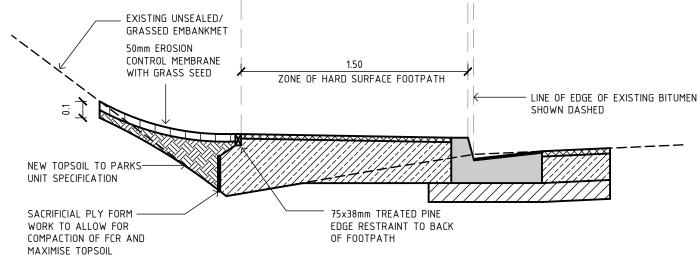ĺ	REV.	REVISION/ ISSUE DESRCIPTION	DATE	
	Α	DA ADDTIONAL INFORMATION REQUEST	25.05.18	
				City of HOBART




PROJECT DESCRIPTION	DRAWN	RFS NUMB	ER
	RU		FS17-0109
	CHECKED	FILE	17-0109 FERN
DRAWING TITLE	-		TREE_WD.dwg
CIVIL WORKS - FOOTPATH SECTIONS	DISCIPLINE	SHEET SI	<sup>ZE</sup> Λ Ͻ
CIVIE WORKS - 10011 ATTI SECTIONS	C		AD
	SHEET NUM	1BER	REVISION
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14.5m COACH
TURNING PATH

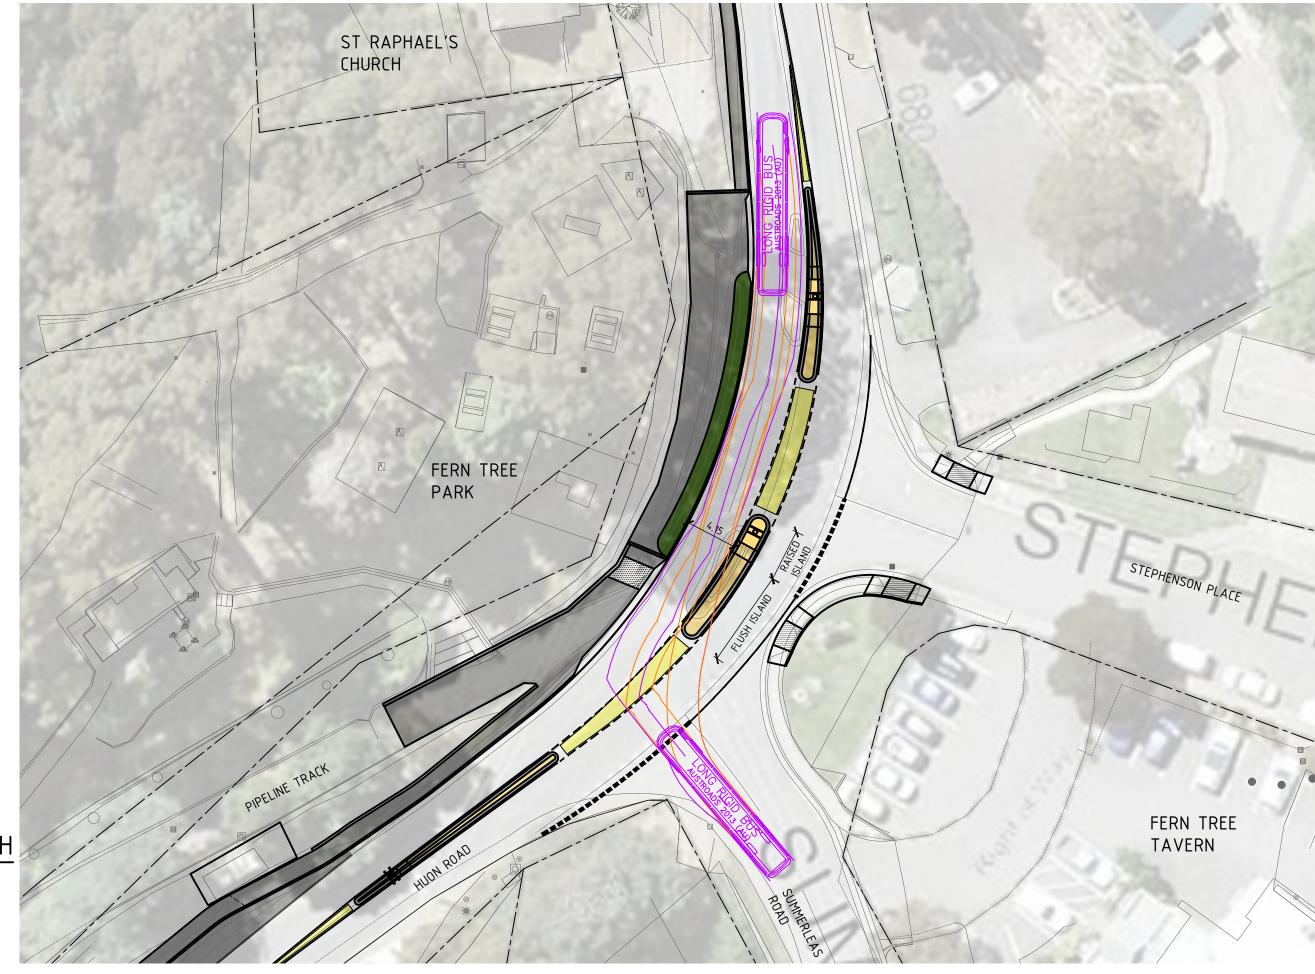Scale 1:300 @ A3



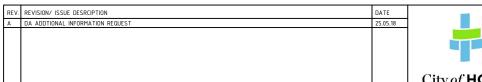

PROJECT DESCRIPTION		DRAWN	RFS NUMBE	.R
FERN TREE PARK VISITOR NODE MASTER PLAN IMPLEMENTATION		RU	RF	-S17-0109
		CHECKED	FILE	17-0109_FERN
DRAWING TITLE				TREE_WD.dwg
CIVIL WORKS - COACH TURN AROUND PATH AT THE FERN TREE TAVERN RIGHT OF WAY	,	DISCIPLINE	SHEET SIZ	· ^ >
		C		ΑJ
CLIENT	TE 25/05/18	SHEET NUM	BER	REVISION
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